



ARCHITECTS

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ADDENDUM NO. 2

Date:	<u>April 08, 2025</u>	Owner:	<u>Division of Public Works</u>
Project:	<u>CWI: Remodel Central Receiving, NMEC</u>		<u>502 N. 4th Street</u>
Project No.:	<u>DPW #23460</u>	No. of Pages	<u>1 page + 2 Attachment</u>

NOTICE TO ALL BIDDERS

You are hereby notified of the following clarifications of and/or revisions to the Drawings and Specifications for the above referenced project.

THIS ADDENDUM is hereby made a part of the project requirements and contract documents for referenced project.

BE SURE to acknowledge it in your Bid Proposal form.

ITEM NO.


Drawings
Architectural

1. **Sheet AI4.01- Interior Elevations**
 - a. See attached new sheet.


2. **Sheet AI4.02 – Door and Window Schedule**
 - a. See attached new sheet.

Attachments: Sheets AI4.01, AI4.02


*****END OF ADDENDUM NO. 2*****

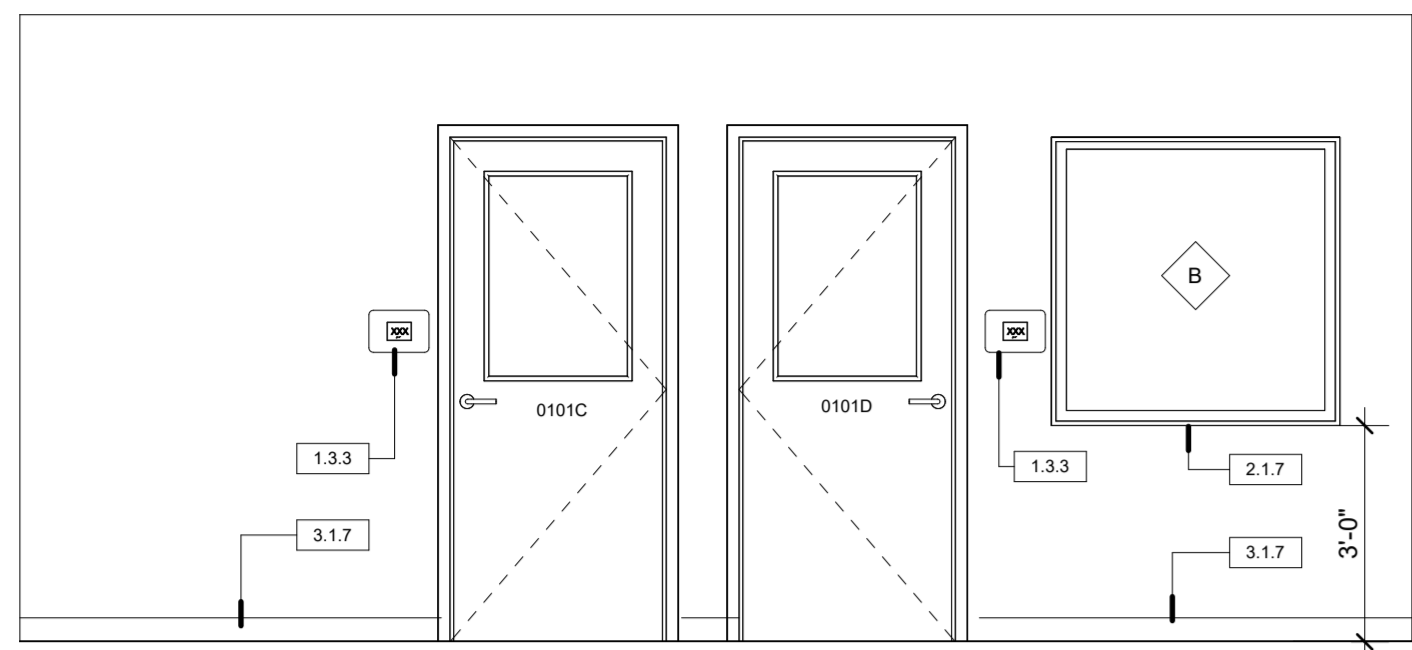


1 MAIL ROOM AND OFFICE ELEVATION
SCALE 3/8" = 1'-0"

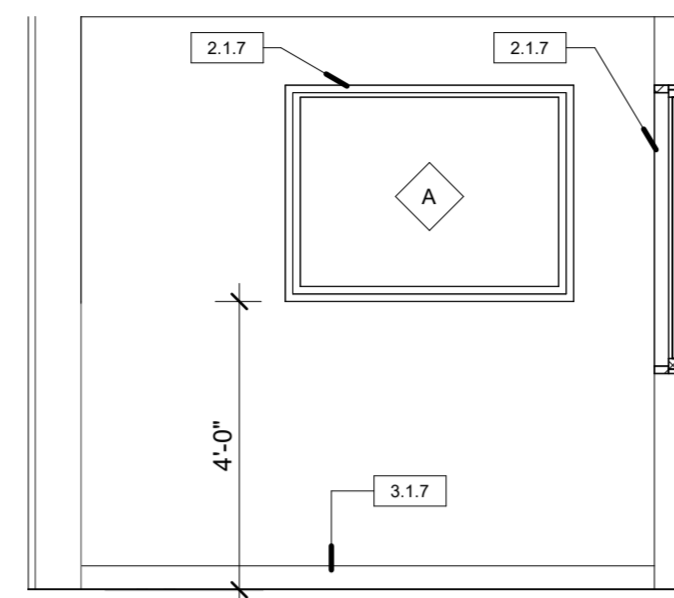


2 OFFICE ELEVATION
SCALE 3/8" = 1'-0"

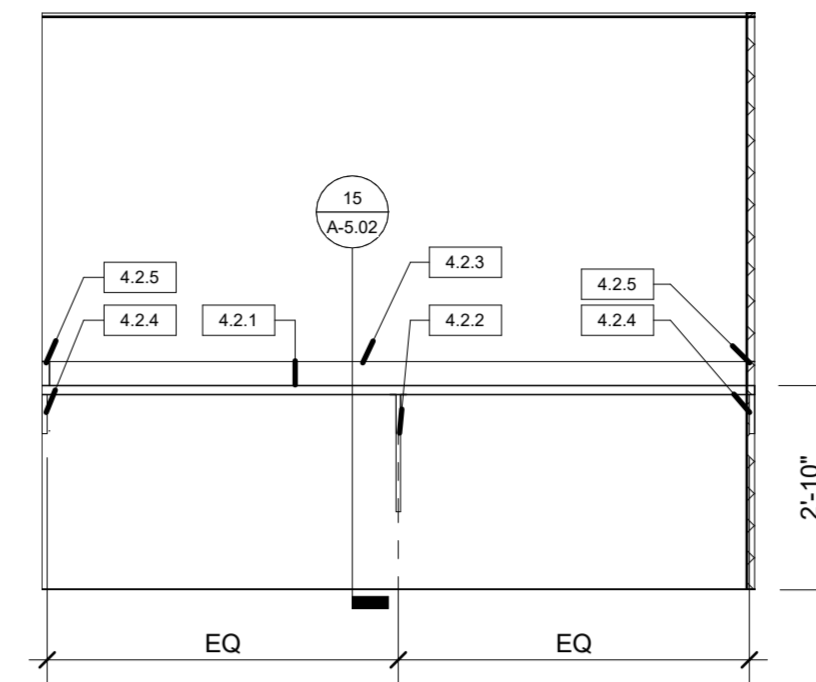


3 MAIL ROOM ELEVATION
SCALE 3/8" = 1'-0"

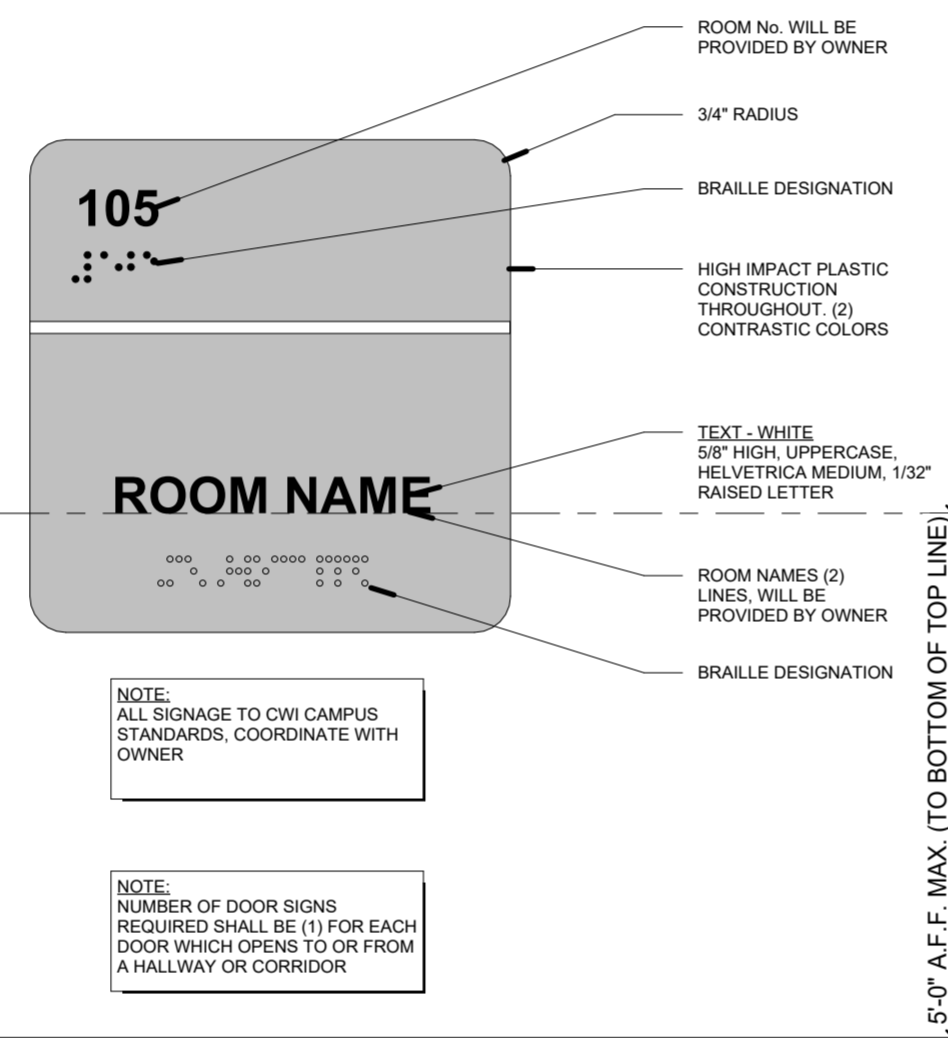

5 ROOM NAME SIGNAGE
SCALE 3" = 1'-0"

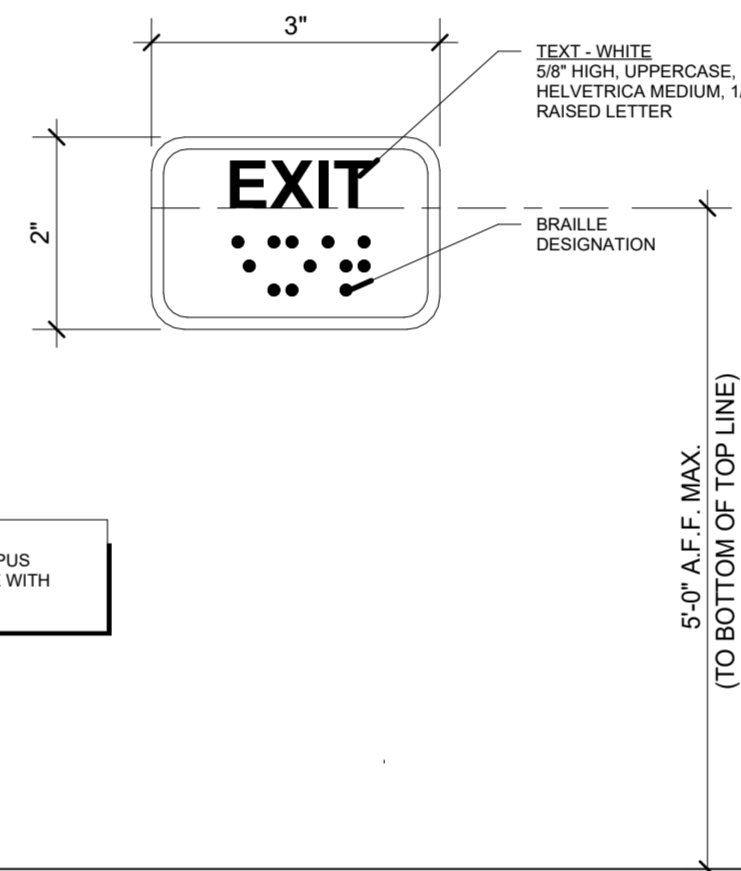

6 EXIT SIGNAGE
SCALE 6" = 1'-0"

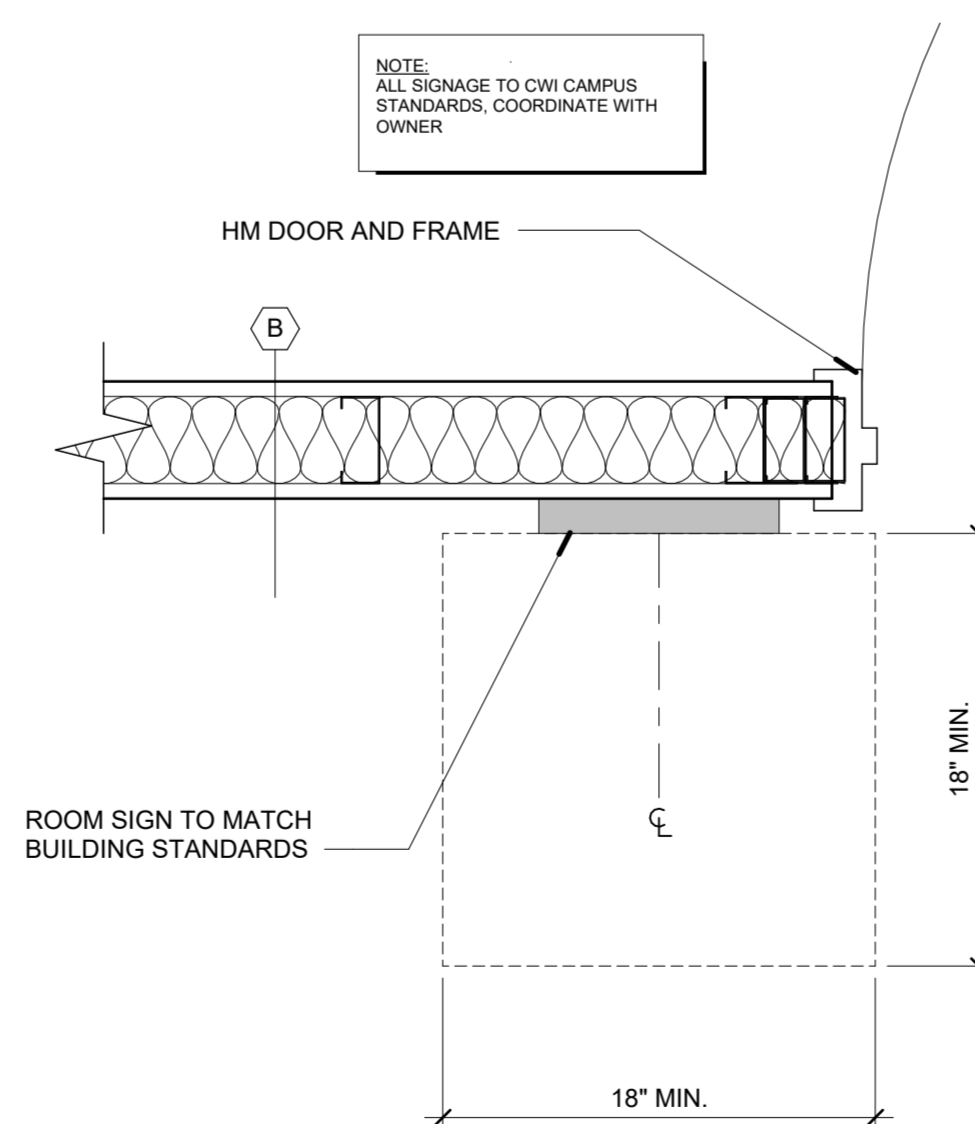

7 ROOM SIGNAGE CLEARANCE
SCALE 1 1/2" = 1'-0"

4 NOT USED
SCALE 1" = 400'-0"

KEYNOTES

- 1.3.3 NEW ROOM NAME SIGNAGE, SEE SPECIFICATION SECTION 101423, PER DETAIL 5/AI4.01
- 2.1.7 NEW HOLLOW METAL WINDOW - PAINT, SEE SPECIFICATION SECTION 081113
- 3.1.7 NEW 4" RUBBER BASE, SEE ROOM FINISH SCHEDULE AND SPECIFICATION 096500
- 4.2.1 NEW PLASTIC LAMINATE COUNTERTOP, SEE SPECIFICATION 123600
- 4.2.2 NEW COUNTERTOP SUPPORT BRACKET, SEE SPECIFICATION 123200
- 4.2.3 COUNTERTOP BACKSPLASH
- 4.2.4 HORIZONTAL WALL CLEAT TO MATCH CABINET FINISH, ANCHOR TO SOLID BLOCKING.
- 4.2.5 COUNTERTOP END SPLASH

PROFESSIONAL RECORD STAMP
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 Keith R. Tisdler
 STATE OF IDAHO
 REVISION

AS ARCHITECTS
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 208.388.1212

DATE **APRIL 2025**
 REF NO. **23-122**
 DPW NO. **23.460**

GENERAL NOTES

- A. ALL CONTRACTORS AND SUB-CONTRACTORS ARE REQUIRED TO REVIEW ALL DRAWINGS AND SPECIFICATIONS, SEE CIVIL, ARCHITECTURAL, STRUCTURAL, PLUMBING, MECHANICAL, AND ELECTRICAL DRAWINGS FOR ADDITIONAL PROJECT REQUIREMENTS.
- B. THE STAGING AREA FOR CONSTRUCTION WILL BE DETERMINED AT THE PRE-BID WITH THE OWNER. ALL DAMAGED AREAS TO BE RESTORED TO ORIGINAL CONDITION AT NO EXPENSE TO THE OWNER.
- C. IT IS THE CONTRACTOR'S RESPONSIBILITY TO INFORM THE ARCHITECT OF ANY DISCREPANCIES OR CONFLICTING INFORMATION IN THE CONSTRUCTION DOCUMENTS. CONTACT THE ARCHITECT WHEN CONFLICTS ARE FOUND.
- D. THIS PROJECT IS REQUIRED TO MEET ALL BUILDING CODES, ACCESSIBILITY CODES, STANDARDS, AND GUIDELINES. IT IS THE CONTRACTOR'S AND SUB-CONTRACTOR'S RESPONSIBILITY TO REVIEW AND UNDERSTAND ALL APPLICABLE ACCESSIBILITY CODES AND CONSTRUCT ALL STRUCTURES AND ALL ASSOCIATED SITE WORK TO MEET THESE REQUIREMENTS. CONTACT THE ARCHITECT WHEN CONFLICTS ARE FOUND.
- E. ALL WALLS, FLOORS AND ROOFS ARE REQUIRED TO BE CONSTRUCTED PER THE LISTED ASSEMBLIES. SEE SHEETS AGO.05
- F. ALL DIMENSIONS ARE TO THE FACE OF FRAMING UNLESS NOTED OTHERWISE (U.N.O.).

city review stamp:

PROJECT **CWI: RENOVATIONS - NMEC CENTRAL RECEIVING**
 PROJECT ADDRESS **5725 E FRANKLIN ROAD**
INTERIOR ELEVATIONS


SHEET NO. **AI4.01**

KEYNOTES


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DOOR TYPES



WINDOW TYPES

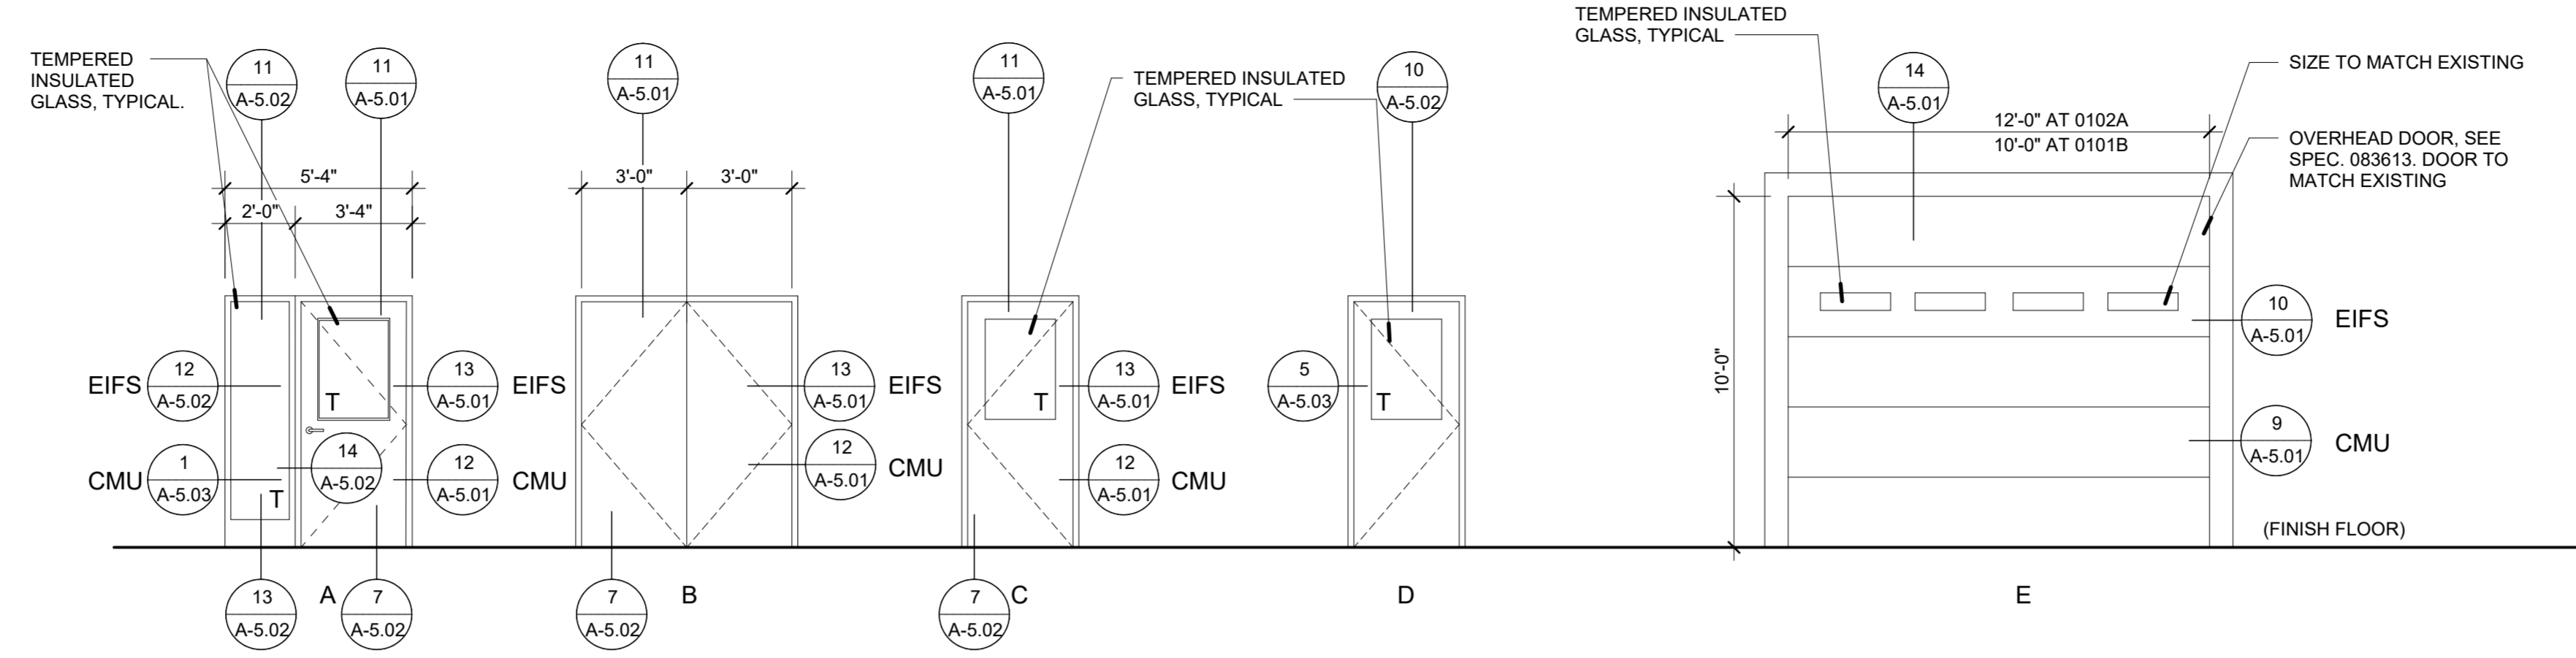DOOR SCHEDULE

DOOR NUMBER	DOOR TYPE	DOOR SIZE			THICKNESS	MATERIAL	FINISH	CORE	FRAME			HARDWARE	NOTES	DOOR NUMBER
		WIDTH	HEIGHT	DEPTH					MATERIAL	FINISH	HARDWARE			
0101A	A	3'-0"	7'-0"		1 3/4"	HM	PAINT	INS.	HM	PAINT	02	NOTE 2	0101A	
0101B	E	10'-0"	10'-0"		1 1/2"						OH-1	NOTE 1	0101B	
0101C	A	3'-0"	7'-0"		1 3/4"	HM	PAINT	HOLLOW	HM	PAINT	04		0101C	
0101D	A	3'-0"	7'-0"		1 3/4"	HM	PAINT	HOLLOW	HM	PAINT	04		0101D	
0102A	E	12'-0"	10'-0"		1 1/2"						OH-1	NOTE 1	0102A	
0102B	B	PAIR 3'-0" X 7'-0"			1 3/4"	HM	PAINT	INS.	HM	PAINT	03	NOTE 2	0102B	
0103A	A	3'-0" x 7'-0" - SIDELIGHT			1 3/4"	HM	PAINT	INS.	HM		02	NOTE 2 & NOTE 3	0103A	
A101E	EXISTING	3'-0" x 7'-0"			1 3/4"	(E) HM	-	-	(E) HM	-	01		A101E	

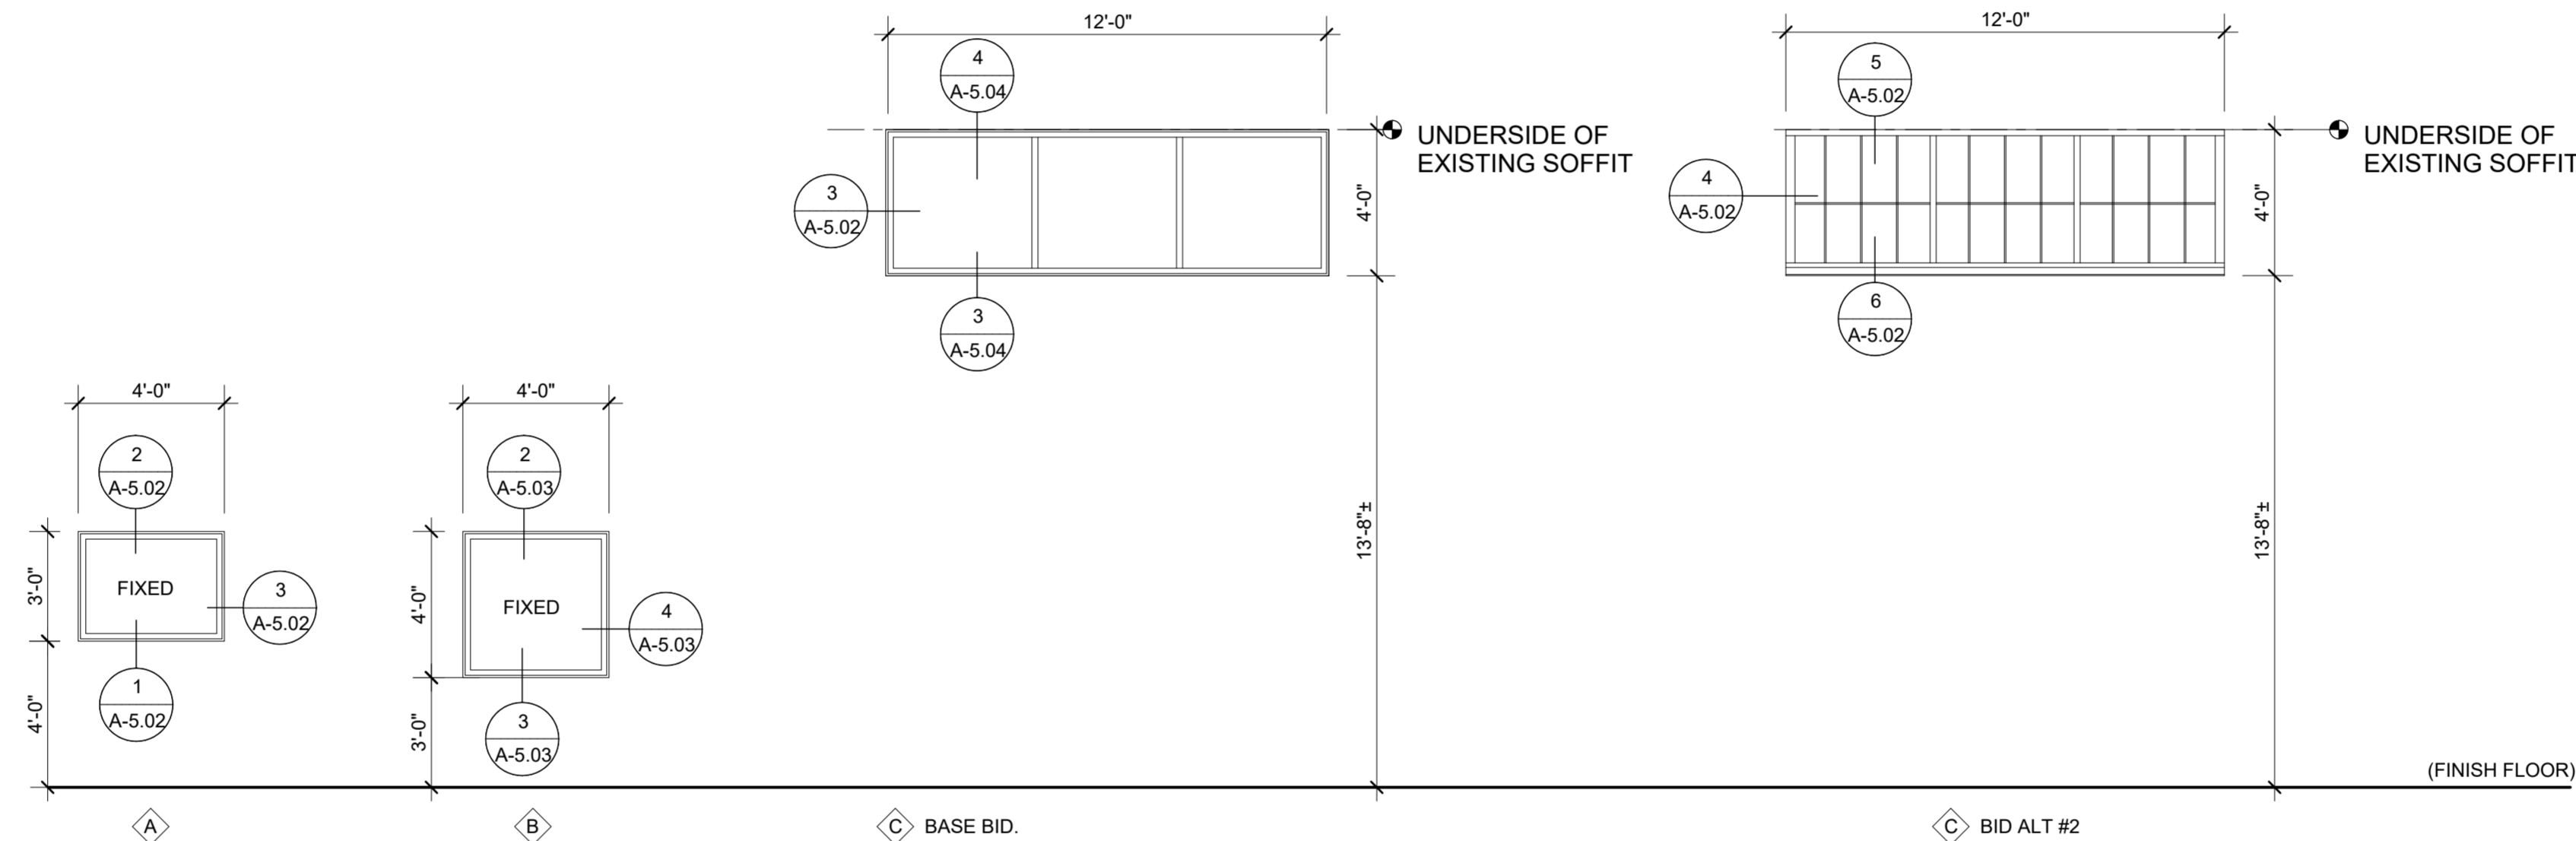- NOTES:
 1. ALL HARDWARE BY SECTIONAL OVERHEAD DOOR MANUFACTURER. MINIMUM 'U' FACTOR FOR OH DOORS = 0.130.
 2. MINIMUM 'U' FACTOR FOR EXTERIOR HM DOOR = 0.150.
 3. MINIMUM 'U' FACTOR FOR SIDELIGHT = 0.280.

LEGEND - DOOR SCHEDULE

(E)	EXISTING
F.F.	FACTORY FINISH
HM	HOLLOW METAL
INS.	INSULATED
P1	PAINT 1
STL	STEEL
SV	STAIN AND VARNISH
TEMP / T	TEMPERED
WD	WOOD

WINDOW SCHEDULE

WINDOW MARK	FRAME SIZE		MATERIAL	FINISH	GLAZING	GLAZING TYPE	INTERIOR TRIM	NOTES
	WIDTH	HEIGHT						
C - ALT #3	12'-0"	3'-9 1/4"						
A	4'-0"	3'-0"	HM	PAINT	DBL PANE	FIXED	GWB	NOTE 1
B	4'-0"	4'-0"	HM	PAINT	SINGLE PANE	FIXED	GWB	
C - BASE	12'-0"	3'-9 1/4"	HM	PAINT	DBL PANE	FIXED	GWB	NOTE 1
C - ALT #2	12'-0"	3'-9 1/4"	HM	PAINT	DBL PANE	FIXED	GWB	NOTE 1
C - ALT #1	12'-0"	3'-9 1/4"	TWPS	FF	T.P.	FIXED	GWB	NOTE 2

- NOTES:
 PROVIDE LOUVER BLINDS AT ALL HOLLOW METAL WINDOWS. SEE SPECIFICATION 122113.

LEGEND - WINDOW SCHEDULE

HM	HOLLOW METAL
TP	TRANSLUCENT PANEL - THERMALLY BROKEN
TWPS	TRANSLUCENT WALL PANEL SYSTEM.

- NOTES:
 1. MINIMUM 'U' FACTOR FOR EXTERIOR HM WINDOWS = 0.280
 2. MINIMUM 'U' FACTOR FOR BID ALT #2 TRANSLUCENT WALL PANEL SYSTEM = 0.050.

ROOM FINISH SCHEDULE

RM#	ROOM NAME	FLOOR FINISH	BASE	CEILING			NORTH WALL		SOUTH WALL		EAST WALL		WEST WALL		NOTE:	RM#
				MATERIAL	FINISH	HEIGHT	MATERIAL	FINISH	MATERIAL	FINISH	MATERIAL	FINISH	MATERIAL	FINISH		
0101A	CENTRAL RECEIVING CENTER	SC	RB	EX. ST.	-	18'-0"±	GWB	P1	GWB	P1	(E) CMU	-	GWB	P1	SEE NOTE 1, 2, 3	0101A
0101B	CENTRAL RECEIVING STORAGE	SC	RB	EX. ST.	-	18'-0"±	GWB	P1	GWB	P1	(E) CMU	-	GWB	P1	SEE NOTE 1, 2, 3	0101B
0101C	MAIL ROOM	SC	RB	GYP.	P1	8'-0"	GWB	P1	GWB	P1	(E) CMU	-	GWB	P1	SEE NOTE 1, 3	0101C
0101D	OFFICE	SC	RB	GYP.	P1	8'-0"	GWB	P1	GWB	P1	(E) CMU	-	GWB	P1	SEE NOTE 1, 3	0101D
0101E	POWERSPORTS STORAGE	SC	-	EX. ST.	-	VARIABLES	(E) CMU	-	(E) CLF	-	(E) CMU	-	(E) CLF	-		0101E
0101F	EXTERIOR STORAGE AREA	SC	-	EX. ST.	-	VARIABLES	(N) CLF	-	(N) CLF	-	(E) CMU	-	(N) CLF	-		0101F

- NOTES:
 1. TOUCH-UP PAINT TO MATCH EXISTING WHERE EXISTING COPING CAP IS TO BE REMOVED
 2. PROVIDE IMPACT RESISTANT GWB AT COLUMN WRAP PER WALL TYPE "D"
 3. OMIT RUBBER BASE AT EXISTING CMU WALLS.

LEGEND - ROOM FINISH

(E)	EXISTING
(N)	NEW
CLF	CHAIN LINK FENCE
EX. ST.	EXISTING STRUCTURE: OPEN WEB STEEL JOIST W/ STEEL DECK ABOVE
FF	FACTORY FINISH
GWB	GYPSUM WALL BOARD. PROVIDE IMPACT RESISTANT GWB, AS NOTED
P1	PAINT 1
RB	4" RUBBER BASE
SC	SEALED CONCRETE

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